

Indicate on Floor Plan: 5. Dimensions

1. Existing Construction 6. New/Existing Doors & Windows

2. New Construction 7. New Finishes

3. North Arrow 8. Property Lines

9. Partition/Wall Construction 4. Scale

CURB

RIVERSIDE AVENUE

NEW WALL CONSTRUCTION - SEE WALL TYPE SCHEDULE BELOW

X-WALL TYPES NOTE: SEE C-I FOR COMPLETE DISCRIPTION OF UL DESIGN NUMBERS PARTITION WALLS: | MALL TYPE | ULL DESIGN NO. U365. APPLY ONE LAYER OF 5/8' TYPE 'X' GARB. TO EXISTING FACE OF NALL BEFORE CONSTRUCTION OF RATED WALL. 5/8' TYPE 'X' GYPSIM WALL BOARD AT BOTH SIDES OF 2X4 WOOD STUDS AND 3 1/2" OF SOUND ATTENUATION BLANKET. WALL TYPE IA 1/2" GYPSUM WALL BOARD BOTH SIDES OF 2X4 WOOD STUDS, TOTAL DEPTH OF 4 1/2".

HALL TYPE IB ONE HOUR RATED WALL CONSTRUCTION, SAME AS HALL TYPE I ABOVE WITH ADDITIONAL LAYER OF 1/2" CEMENT BOARD AND CERAMIC TILE AT BATH TUB/SHOWER SURROUND. TOTAL DEPTH OF 6 3/0". WALL TYPE IC 1/2" GYPSUM WALL BOARD EITHER SIDE OF 2X4 WOOD STUDS WITH 3 1/2" SOUND ATTENUATION BLANKETS. TOTAL DEPTH OF 4

WALL TYPE ID 1/2" GYPSUM WALL BOARD EITHER SIDE OF 2X3 WOOD STUDS WITH 3 1/2" SOUND ATTENUATION BLANKETS. TOTAL DEPTH OF 3

WALL TYPE IE 1/2" GYPSUM WALL BOARD AT FINISHED SIDE OF 2X3 WOOD STUD WALL. TOTAL DEPTH OF 3".

F WALL TYPE IE 1/2" 6YPSUM WALL BOARD AT FINISHED SIDE OF 2X4 WOOD STUD WALL. TOTAL DEPTH OF 4".

EXTERIOR WALLS:

2 MALL TYPE 2 U.L. DESIGN NO. USS6. ONE HOUR RATED MALL CONSTRUCTION. 5/8" TYPE "X" SYPSIM MALL BOARD AT INTERIOR SIDE OF 2X4 MOOD STUD MALL AND FRT 1/2" PLYMOOD AT EXTERIOR SIDE AND 3 1/2" OF SOUND ATTENIATION BLANKET. INSTALL VINYL. SIDING AT EXTERIOR PER UL. DESIGN REQUIREMENTS. TOTAL DEPTH OF MALL CONSTRUCTION 15 4 3/4". NOTE. MALL TYPE 2 OCCURS VERTICALLY ABOVE ROOF OF ADJOINING PROPERTY. DO NOT BUILD NO 4/25 EXERTICAL BODY MAIL. ON OVER EXISTING PARTY WALL.

WALL TYPE 3 U.L. DESIGN NO. 1856 - ONE HOUR RATED WALL
CONSTRUCTION. SAME AS WALL TYPE 2 ABOVE WITH I/2* OF STUCCO
IN LIEU OF VINYL SIDING AND 2X6 WOOD STUDS IN LIEU OF 2X4.
TOTAL DEPTH OF WALL CONSTRUCTION IS 7 I/2*.

FURRED WALLS: 5 WALL TYPE 5 | 15/8" METAL FURRING WITH 1/2" GYPSUM WALL BOARD AND 15/8" RIGID INSULATION. TOTAL DEPTH OF 2 1/8".

5A AND 3 1/2" BATT INSULATION. TOTAL DEPTH OF 4".

| MALL_TYPE 5B | SAME AS WALL TYPE 5 ABOVE WITHOUT RIGID INSULATION.

NEW SOLID CORE WOOD DOOR IN EXIST, OPING. FINAL UNIT TO BE SELECTED.

KEYED CONSTRUCTION NOTES

8

2 NOT USED.

NEN VINYL REPLACEMENT DOUBLE HUNG WINDOW IN EXIST, OPNG. EXISTING MOOD JAMB TRIM TO REMAIN, FURNISH NEW IX MOOD HEAD & SILL CASING PAINT GRADE TRIM. FINAL MANUFACTURER & UNIT TO BE

4 NEH VINTL DOUBLE HANG MINDOM IN NEW OPENING. NEW IX MOOD TRIM PAINT GRADE SILL, JAMB AND HEAD. FINAL MANIFACTURER & UNIT TO BE SELECTED.

5) LINE OF NEW P.T. WOOD DECK PROJECTION ABY DASHED.

NEW WALL AND FLOOR KITCHEN CABINETS. COORDINATE FINAL SELECTION WITH OWNER. PROVIDE ADEQUATE BLOCKING FOR WALL MOUNTED LITEMS.

(1) KITCHEN APPLIANCES AND FIXTURES SHOWN FOR PRELIMINARY LAYOUT PURPOSES ONLY. COORDINATE FINAL SELECTION AND UNIT REGUIREMENTS FOR PLIMENING, ELECTRICAL, DIMENSIONAL & VENTING, INCLUDE GARBAGE DISPOSER, SICKAICAL, DISHWASHER AND REFRIGERATOR.

PEM BUILT-IN RECESSED ENAMELED STEEL BATH TUB WITH CERAMIC TILE SURROUND. COORDINATE FINAL SELECTION WITH OWNER. INSTALL CEMENT BOARD AT TILE SURROUND.

NEW TOILET. COORDINATE FINAL SELECTION W/ OWNER.

NEW SINK, FAUCETS & MEDICINE CABINET MIRRORCOMBINATION.
COORDINATE FINAL SELECTION WITH OWNER. NEW HARDWOOD HANDRAIL.

NEW BUILT-IN WOOD SHELVING. MAXIMIZE OPNG, DIMENSIONS WITH AVAILABLE EXIST. CONDITIONS, (2)

(B) NEW ELECTRICAL PANEL.

(4) NEW ELECTRIC METER & DISCONNECT SWITCH. LOCATION. COORDINATE FINAL LOCATION WITH CLEARANCES REQUIRED BY BG&E'S DESIGN CRITERIA REQUIREMENTS.

(5) CONSTRUCT NEW WOOD ENCLOSURE & SERVICE DOOR AT EXIST, GAS METER. VERIFY UNIT DIMENSIONAL REQUIREMENTS IN FIELD.

40 GALLON CAPACITY ELECTRIC MATER HEATER. COORDINATE UNIT SELECTION NITH AVAILABLE DIMENSION UNDER STAIRS. ADJIST LOCATION TOWARD ACCESS PANEL IF FIRTHER CLEARNCE IS

PROVIDE FLOOR INSULATION BELOW NEW FLOOR CONSTRUCTION.

PATCH CONCRETE SIDEWALK TO MATCH EXISTING AT AREAS ONLY DISTURBED BY CONSTRUCTION ACTIVITY.

PRECAST CONCRETE STAIRS, PROVIDE WELDED STEEL FACTORY PRIMED FIELD PAINTED HANDRAILS ON ONE SIDE OF STAIR.

NEW PINE STAIRS. COORDINATE FINAL RISER HEIGHTS WITH FINAL FLOOR FINISH DEPTHS.

(22) NEW STACKED WASHER/DRYER UNIT. COORDINATE FINAL YENTING AND AND PLIMBING WITH FINAL SELECTION. FLAT STUD BIFOLD DOOR JAMB RETURNS.

PLYWOOD SOFFIT OVERHANG ABOVE OF 12" DASHED. PROVIDE MIDGET LOWERS AT 24" O.C. OR EQUIVALENT CONT. SCREENED SOFFIT LOWER.

ARCHITECTS

4321 West End Road Baltimore, Maryland (t) 123.456.7891

STRUCTURAL ENGINEERS

4321 East End Road Baltimore, Maryland

& ADDITION DOCUMENTS Owners:
Mr. & Ms. Smith
6 East Home Street
Baltimore, Maryland RENOVATION & CONSTRUCTION I

FOR EXAMPLE

CONSTRUCTION DESIGNED:

DRAWN:


CHECKED:

ONLY: NOT FOR

APPROVED: REVISIONS DATE

JOB#: 15-005 CADD FILE: DATE: AUGUST 1, 2016 SCALE: AS NOTED



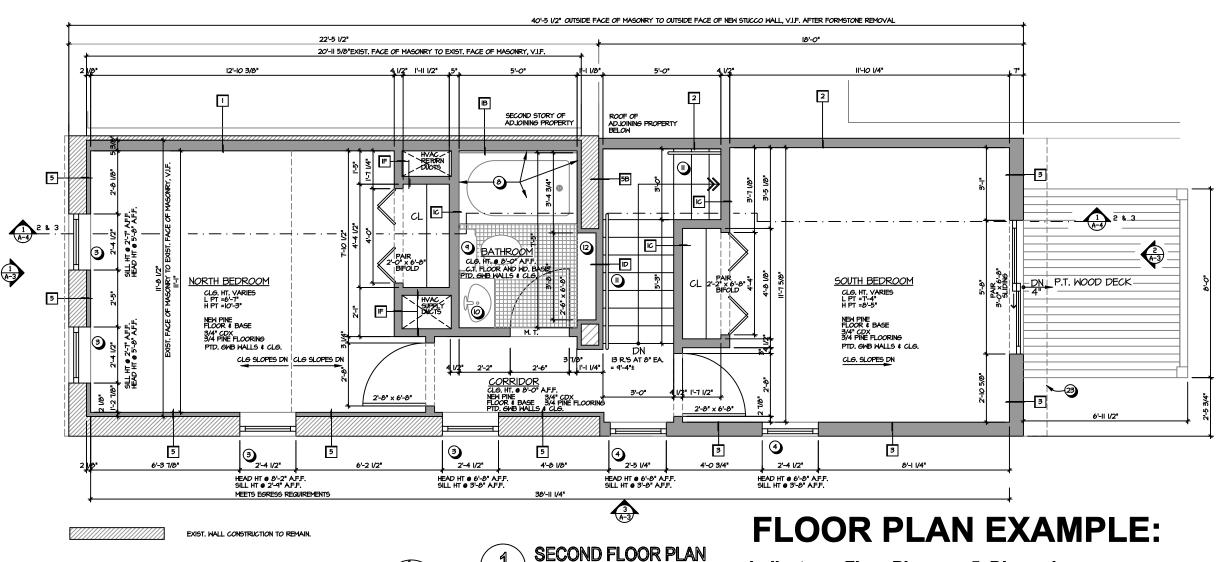

Indicate on Floor Plan: 5. Dimensions

6. New/Existing Doors & Windows 1. Existing Construction

2. New Construction 7. New Finishes

3. North Arrow 8. Property Lines

(5) CONSTRUCT NEW MOOD ENCLOSURE & SERVICE DOOR AT EXIST. GAS METER. VERIFY UNIT DIMENSIONAL REQUIREMENTS IN FIELD.

(1) 40 GALLON CAPACITY ELECTRIC MATER HEATER. COORDINATE UNIT SELECTION WITH AVAILABLE DIMENSION UNDER STAIRS. ADJUST LOCATION TOWARD ACCESS PANEL IF FURTHER CLEARNCE IS REQUIRED.

(6) NOT USED

9. Partition/Wall Construction 4. Scale

WALL TYPES X NOTE: SEE C-1 FOR COMF	LETE DISCRIPTION OF UL DESIGN NUMBERS	KEYED CONSTRUCTION NOTES		
PARTITION WALLS: WALL TYPE JUL DESIGN NO. 1865. APPLY ONE LAYER OF 5/8" TYPE "Y GHB. TO EXISTING FACE OF WALL BEFORE CONSTRUCTION OF RATED WALL. 5/8" TYPE "X" GYPSIM WALL BOARD AT BOTH SIDES OF 2X4 WOOD STIDOS AND 3 I/2" OF SOUND ATTENUATION BLANKET. TOTAL DEPTH OF 5 3/8". WALL TYPE IA 1/2" GYPSIM WALL BOARD BOTH SIDES OF 2X4 WOOD STIDG. TOTAL DEPTH OF 4 1/2".	EXTERIOR WALLS: 2 WALL TYPE 2 U.L. DESIGN NO. 1356. ONE HOUR RATED WALL CONSTRUCTION. 5/6" TYPE "X" GYPSIM WALL BOARD AT INTERIOR SIDE OF 224 HOOD STID WALL AND FRT 12" PLYMOOD AT EXTERIOR SIDE AND 3 1/2" OF SOUND ATTENNATION BLANKET. INSTALL VINYL SIDING AT EXTERIOR PER U.L. DESIGN REQUIREMENTS. TOTAL DEPTH OF WALL CONSTRUCTION IS 4 3/4". NOTE. WALL TYPE 2 OCCURS VERTICALLY ABOVE ROOF OF ADJOINING PROPERTY. DO NOT BUILD ON OVER EXISTING PARTY WALL	NEW SOLID CORE WOOD DOOR IN EXIST. OPING. FINAL UNIT TO BE SELECTED. (2) NOT USED. NEW VINY, REPLACEMENT DOUBLE HUNG HINDOM IN EXIST. OPING. (3) EXISTING MOOD JAMB TRIM TO REMAIN, FIRRIGH NEW IX MOOD HEAD & SILL CAGING PAINT GRADE TRIM, FINAL MANUFACTURER & UNIT TO BE SELECTED. (4) NEW VINY, DOUBLE HUNG HINDOM IN NEW OPENING. NEW IX WOOD TRIM PAINT GRADE SILL, JAMB AND HEAD. FINAL MANIFACTURER & UNIT TO	NEW BUILT-IN WOOD SHELVING. MAXIMIZE OPING, DIMENSIONS WITH AVAILABLE EXIST, CONDITIONS.	B PROVIDE FLOOR INSULATION BELOW NEW FLOOR CONSTRUCTION. PATCH CONCRETE SIDEWALK TO MATCH EXISTING AT AREAS ONLY DISTURBED BY CONSTRUCTION ACTIVITY. PRECAST CONCRETE STAIRS. PROVIDE WELDED STEEL FACTORY PRIMED FIELD PAINTED HANDRAILS ON ONE SIDE OF STAIR.
MALL TYPE IB ONE HOUR RATED WALL CONSTRUCTION. SAME AS MALL TYPE I ABOVE WITH A DOTITIONAL LAYER OF I/2" CEPENT BOARD AND CERAMIC TILE AT BATH TUB/SHOWER SURROUND. TOTAL DEPTH OF 6 3/b". MALL TYPE IC I/2" SYPSIM WALL BOARD EITHER SIDE OF 2X4 WOOD STUDS WITH 3 I/2" SOUND ATTENUATION BLANKETS. TOTAL DEPTH OF 4	MALL TYPE 3 U.L. DESIGN NO. USS6 - ONE HOUR RATED WALL 3 CONSTRUCTION, SAME AS MALL TYPE 2 ABOVE WITH 12" OF STUCCO IN LIEU OF VINYL SIDING AND 2X6 WOOD STUDS IN LIEU OF 2X4. TOTAL DEPTH OF MALL CONSTRUCTION IS 7 1/8". HALL TYPE 4 NOT USED. FIIDDET) WALL I.S.	BE SELECTED. 5 LINE OF NEW P.T. WOOD DECK PROJECTION ABY DASHED. 6 NEW WALL AND FLOOR KITCHEN CABINETS. COORDINATE FINAL SELECTION WITH OWNER. PROVIDE ADEQUATE BLOCKING FOR WALL MOUNTED TIETHS.	(B) NEM ELECTRICAL PANEL. WEM ELECTRIC METER & DISCONNECT SMITCH. LOCATION. COORDINATE FINAL LOCATION WITH CLEARANCES REQUIRED BY B94ES DESIGN CRITERIA REQUIREMENTS. (E) CONSTRUCT NEW MOOD ENGLOSURE & SERVICE DOOR AT EXIST. GAS	NEW PINE STAIRS, COORDINATE FINAL RISER HEIGHTS WITH FINAL FLOOR FINISH DEPTHS. NEW STACKED WASHER/DRYER UNIT. COORDINATE FINAL VENTING AND AND PLUMBING WITH FINAL SELECTION. FLAT STUD BIFOLD DOOR JAMB RETURNS.

(1) KITCHEN APPLIANCES AND FIXTURES SHOWN FOR PRELIMINARY LAYOUT PURPOSES ONLY. COORDINATE FINAL SELECTION AND UNIT REGUIREMENTS FOR PLUMBING, BLECTRICAL, DIMENSIONAL & VENTING. INCLIDE GARBAGE DISPOSER, SINK AND FAILCETS, STOVE AND OVEN, DISHMASHER AND REFRIGERATOR.

NEW BUILT-IN RECESSED ENAMELED STEEL BATH TUB WITH CERAMIC
THE SURROUND. COORDINATE FINAL SELECTION WITH OWNER. INSTALL
CEMENT BOARD AT TILE SURROUND.

NEW WALL CONSTRUCTION - SEE WALL TYPE SCHEDULE BELOW

FURRED WALLS:

5 WALL TYPE 5 | 15/8" METAL FURRING WITH 1/2" GYPSUM WALL BOARD AND 15/8" RIGID INSULATION. TOTAL DEPTH OF 2 1/8".

MALL TYPE 5A 2X4 WOOD STUDS WITH I/2" GYPSUM WALL BOARD AND 3 I/2" BATT INSULATION. TOTAL DEPTH OF 4".

MALL TYPE 5B SAME AS WALL TYPE 5 ABOVE WITHOUT RIGID INSULATION.

WALL TYPE ID 1/2" GYPSUM WALL BOARD EITHER SIDE OF 2X3 WOOD STUDS WITH 3 1/2" SOUND ATTENUATION BLANKETS, TOTAL DEPTH OF 3

WALL TYPE IE 1/2" SYPSUM WALL BOARD AT FINISHED SIDE OF 2X3 WOOD STUD WALL. TOTAL DEPTH OF 3".

WALL TYPE IE 1/2" SYPSUM WALL BOARD AT FINISHED SIDE OF 2X4 WOOD STUD WALL. TOTAL DEPTH OF 4".

22) NEW STACKED WASHER/DRYER UNIT. COORDINATE FINAL VENTING AND AND PLIMBING WITH FINAL SELECTION. FLAT STUD BIFOLD DOOR JAMB RETURNS. PLYWOOD SOFFIT OVERHANG ABOVE OF 12" DASHED. PROVIDE MIDGET LOWERS AT 24" O.C. OR EQUIVALENT CONT. SCREENED SOFFIT LOWER.

ARCHITECTS

4321 West End Road Baltimore, Maryland (t) 123.486.78QI

STRUCTURAL ENGINEERS

4321 East End Road Baltimore, Maryland

RENOVATION & ADDITION CONSTRUCTION DOCUMENTS

Owners:
Mr. & Ms. Smith
6 East Home Street
Baltimore, Maryland

FOR EXAMPLE ONLY: **NOT FOR** CONSTRUCTION

DESIGNED: DRAWN: CHECKED: APPROVED:


REVISIONS	DAT

JOB#: 15-005 CADD FILE: DATE: AUGUST 1, 2016

A-2

SCALE: AS NOTED

FLOOR PLAN

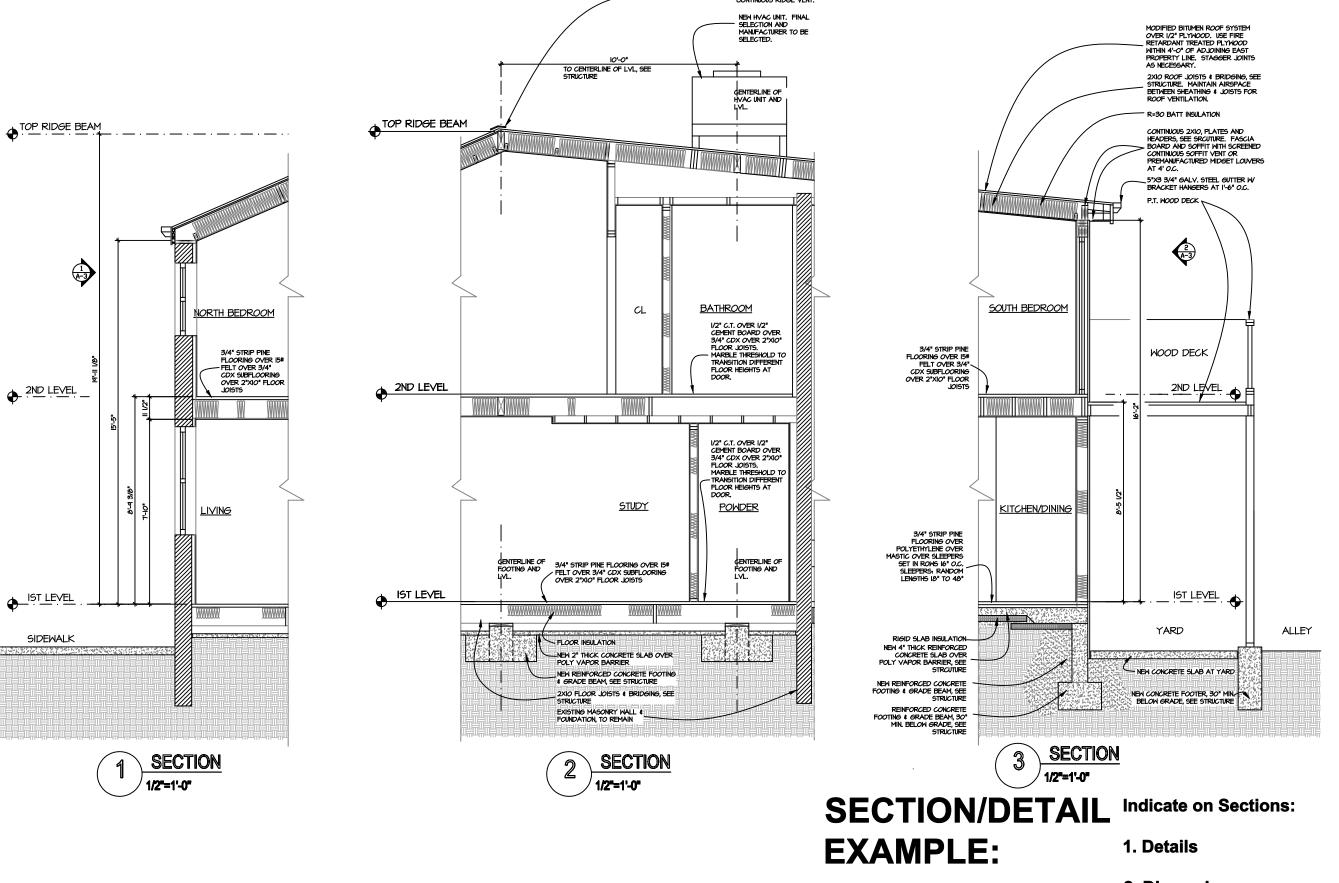

4321 West End Road Baltimore, Maryland (t) 123.486.7891

ARCHITECTS

STRUCTURAL ENGINEERS

4321 East End Road Baltimore, Maryland (t) 123.486.7891

RENOVATION & ADDITION
CONSTRUCTION DOCUMENTS
Owners:
Mr. & Ms. Smith
6 East Home Street
Baltimore, Maryland

FOR EXAMPLE ONLY: NOT FOR CONSTRUCTION

DESIGNED: DRAWN: CHECKED: APPROVED:

REVISIONS DATE

JOB#: 15-005 CADD FILE: DATE: AUGUST 1, 2016 SCALE: AS NOTED





SECTIONS

2. Dimensions

3. Scale

4. Floor Elevations

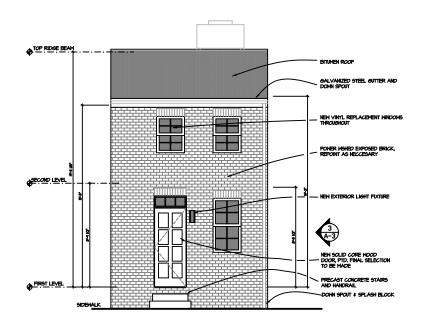


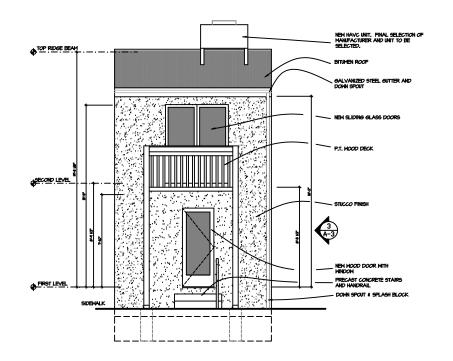

BUILDING ELEVATION
1/4"=1'-0"

BUILDING ELEVATION

1/4"=1"-0"

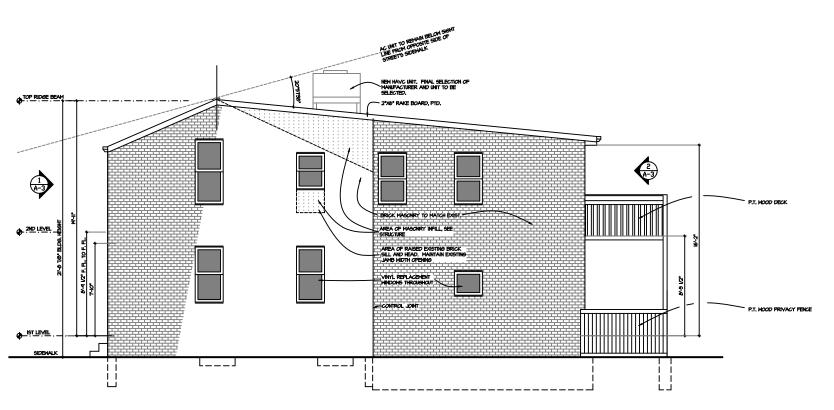

3 BUILDING ELEVATION
1/4"=1'-0"

BUILDING ELEVATION EXAMPLE:

Indicate on Building Elevations:

- 1. Existing Construction to Remain
- 2. New Construction
- 3. New Finishes
- 4. Scale
- 5. Dimensions
- 6. Floor Elevations, Building Height
- 7. Existing & New Windows & Doors

ARCHITECTS

4321 West End Road Baltimore, Maryland (t) 123.456.7891

STRUCTURAL ENGINEERS

4321 East End Road Baltimore, Maryland (t) 123.486.7891

RENOVATION & ADDITION
CONSTRUCTION DOCUMENTS
Owners:
Mr. & Ms. Smith
6 East Home Street
Baltimore, Maryland


FOR EXAMPLE ONLY:
NOT FOR CONSTRUCTION

DESIGNED: DRAWN: CHECKED:

REVISIONS	DATE		

JOB#: 15-005 CADD FILE: DATE: AUGUST 1, 2016 SCALE: AS NOTED



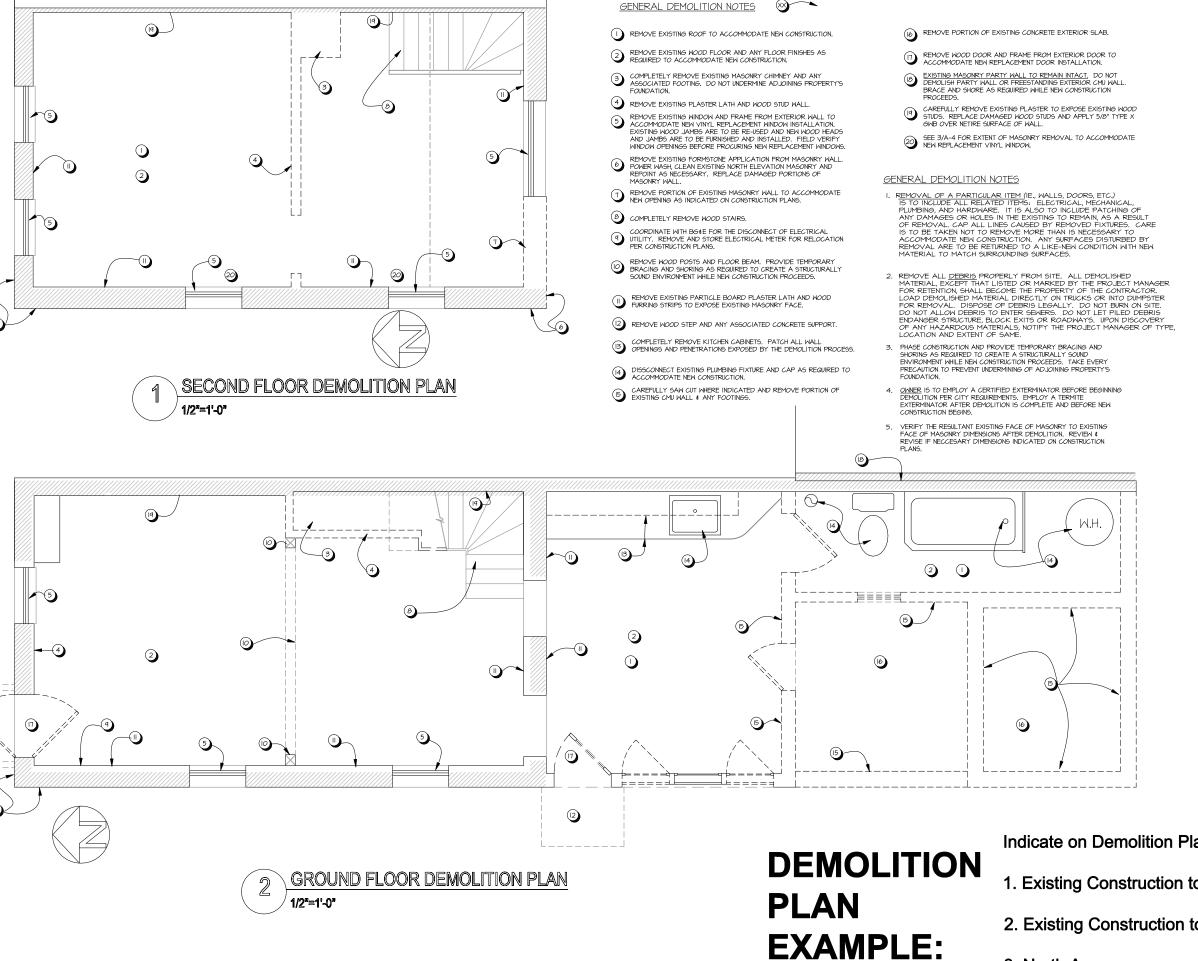

Indicate on Demolition Plan:

- 1. Existing Construction to Remain
- 2. Existing Construction to be Removed
- 3. North Arrow
- 4. Scale

ARCHITECTS

4321 West End Road Baltimore, Maryland (t) 123.456.7891

STRUCTURAL ENGINEERS

4321 East End Road Baltimore, Maryland (t) 123.456.7891

& ADDITION DOCUMENTS Owners:
Mr. & Ms. Smith
6 East Home Street
Baltimore, Maryland RENOVATION & CONSTRUCTION I

FOR EXAMPLE ONLY: NOT FOR CONSTRUCTION

DESIGNED:

REVISIONS	DATE

JOB#: 15-005 CADD FILE: DATE: AUGUST 1, 2016 SCALE: AS NOTED

